

Min. 40% of new light fittings to use fluorescent, compact fluorescent or LED lamps All new showerheads & taps to have a flow rate no greater than 9 l/min. or a min. 3 star water rating All new toilets to use no greater than 4 litres per average flush or a min. 3 star water rating No insulation required for new floor above garage Min. R1.16 insulation to be added to new brick veneer external walls Min. R1.3 insulation to be added to new external walls with lightweight cladding No insulation required to new internal walls with lightweight cladding

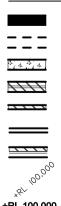
No insulation required to new internal wall shared with garage Min. R2.5 insulation to new ceilings

Foil sarking under new roof

Dark coloured new roof (solar absorptance >0.7) All new windows & glazed doors to be standard aluminium frames with single clear glass (or to have specs no greater than Uw 7.63 & SHGCw 0.75) W5 to have min. 504mm hood at its head

				C DA SUBMISSION B REVISED PRE-DA VERSION A PRE-DA VERSION	ORAWING TITLE: SITE PLAN GROUND FLOOR PLAN 04.11.2024 03.042024 29.02.2024	ALTERATIONS AND ADDITIONS TO EXISTING DUAL OCCUPANCY ADDRESS: 2 Crieff Street, Ashbury NSW 2193	SCALE: 1:100 on A1 SHEET: 1 JOB NO: 23215
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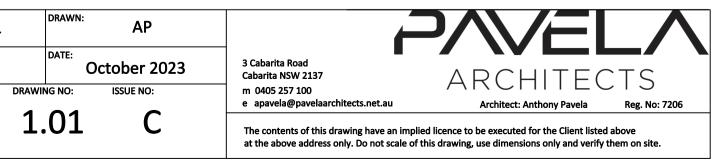
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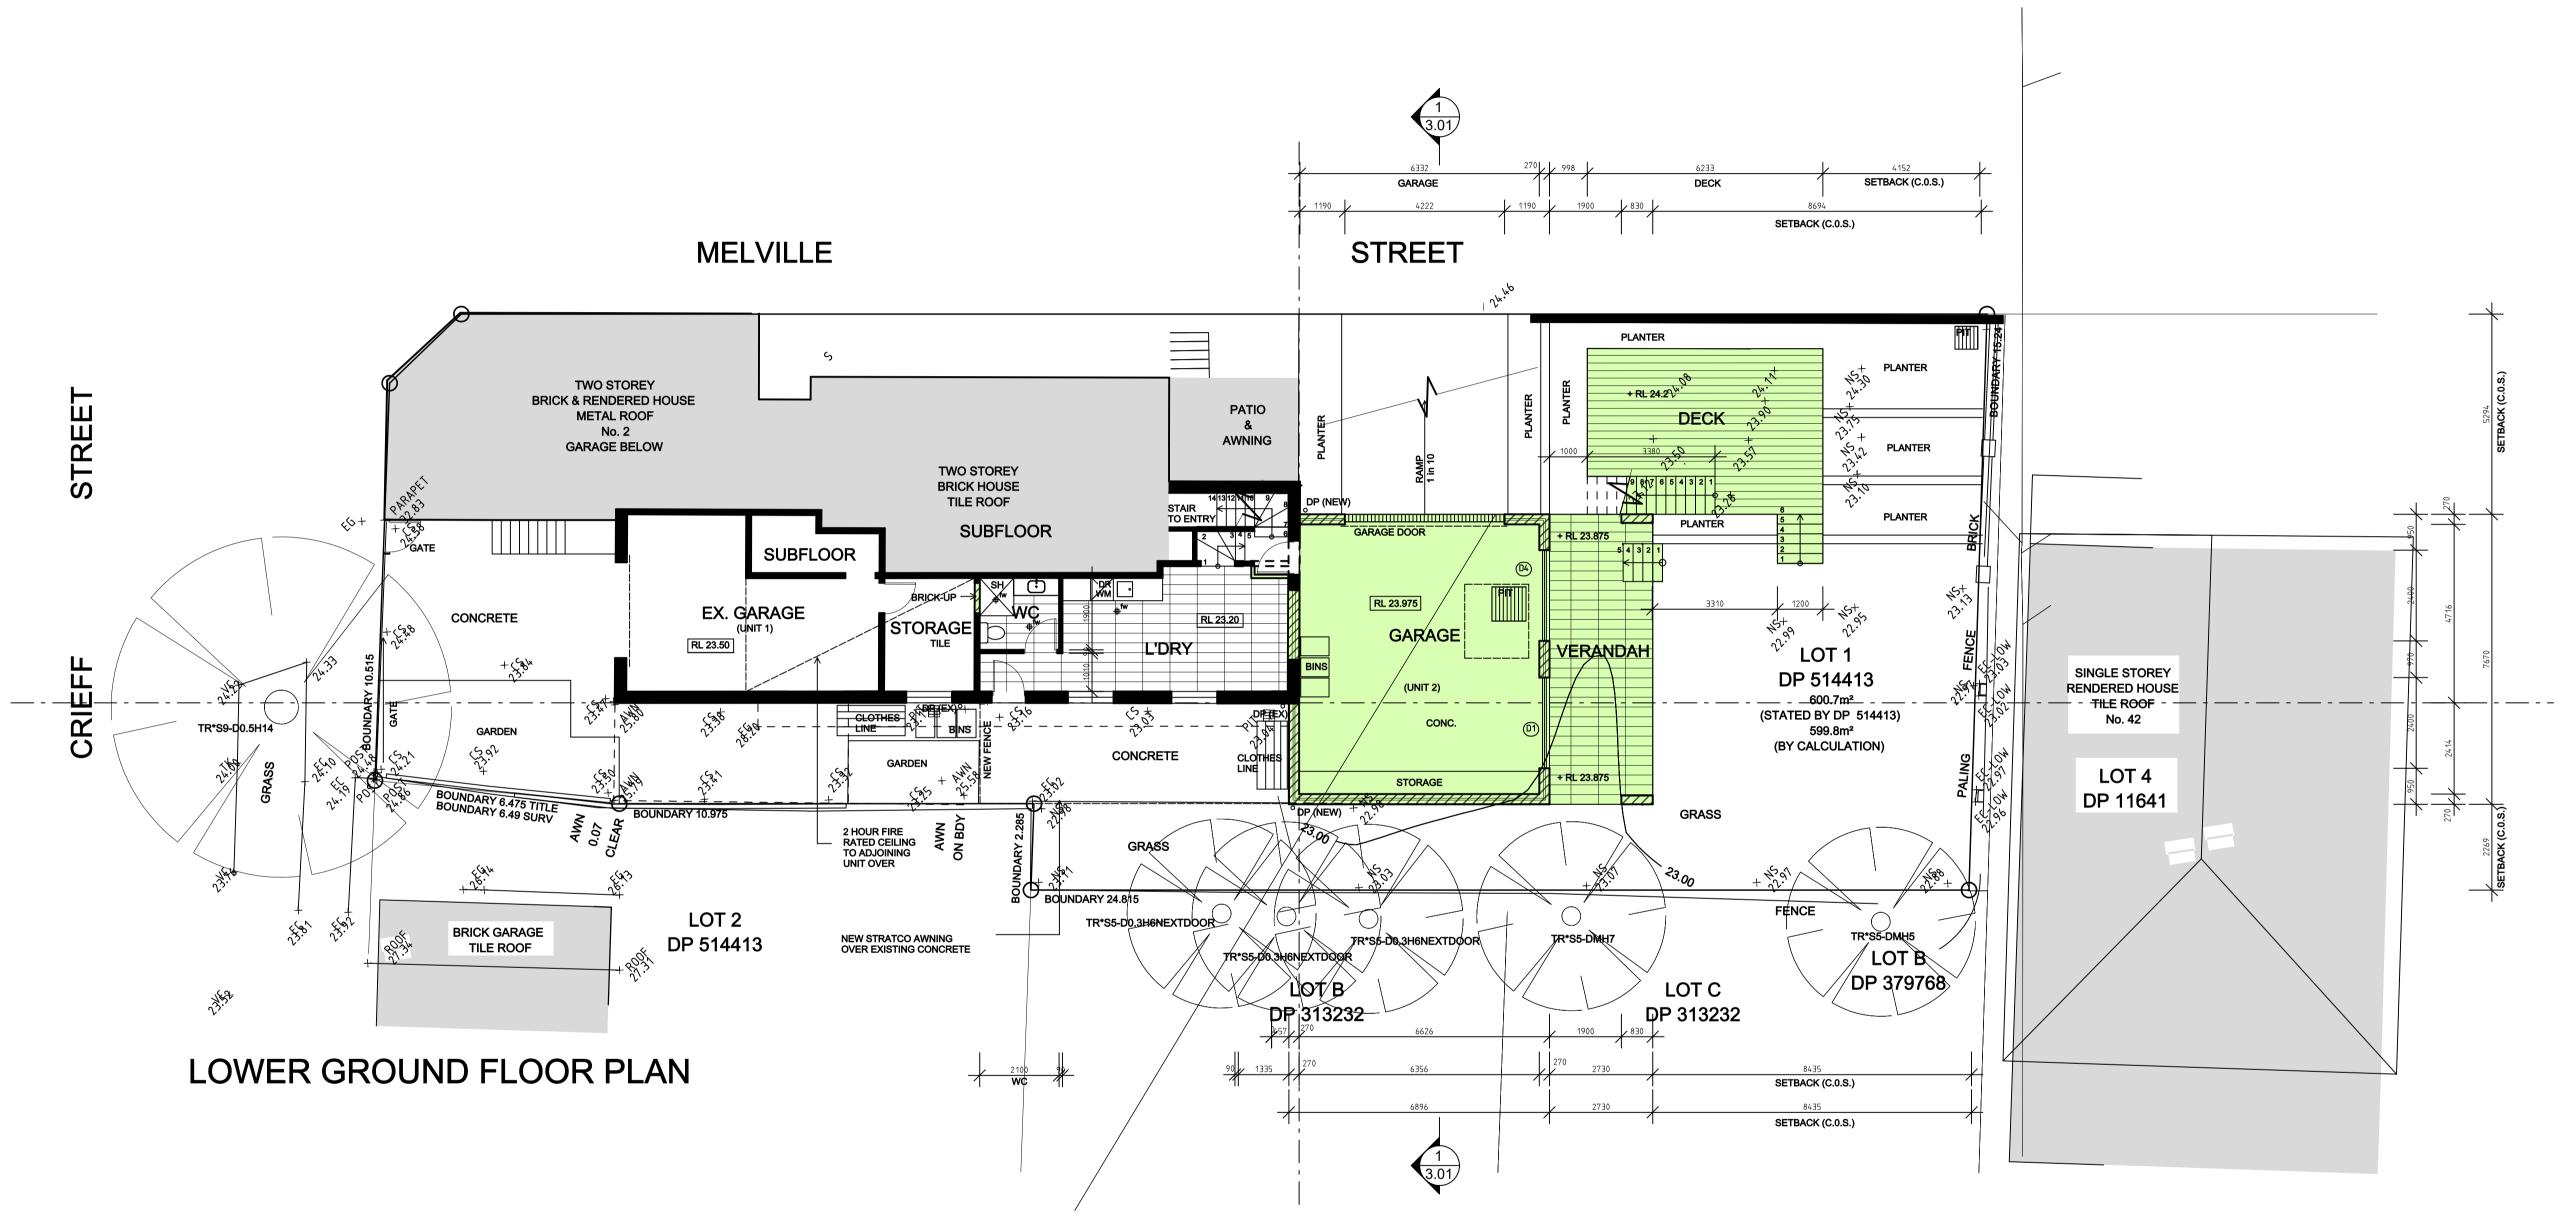


EXISTING WALLS TO REMAIN EXISTING WALLS TO BE DEMOLISHED DINCEL CONCRETE WALL CAVITY BRICK WALL NEW SINGLE BRICK WALL NEW STUD FRAMED FALL

NEW BRICK VANEER CAVITY WALL

EXISTING LEVEL +RL 100.000 PROPOSED LEVEL





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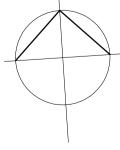
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				CBA	DA SUBMISSION 25.11.2024 REVISED PRE-DA VERSION 03.042024 PRE-DA SUBMISSION 229.02.2024	DRAWING TITLE: LOWER GROUND FLOOR PLAN	ALTERATIONS AND ADDITIONS TO EXISTING DUAL OCCUPANCY ADDRESS: 2 Crieff Street, Ashbury NSW 2193	SCALE: 1:100 on A1 SHEET: 1 JOB NO: 23215

LEGEND

EXISTING WALLS TO REMAIN _ _ _ EXISTING WALLS TO BE DEMOLISHED _ _ _ and the second DINCEL CONCRETE WALL ////CAVITY BRICK WALL NEW SINGLE BRICK WALL NEW STUD FRAMED FALL ____ NEW BRICK VANEER CAVITY WALL EXISTING LEVEL

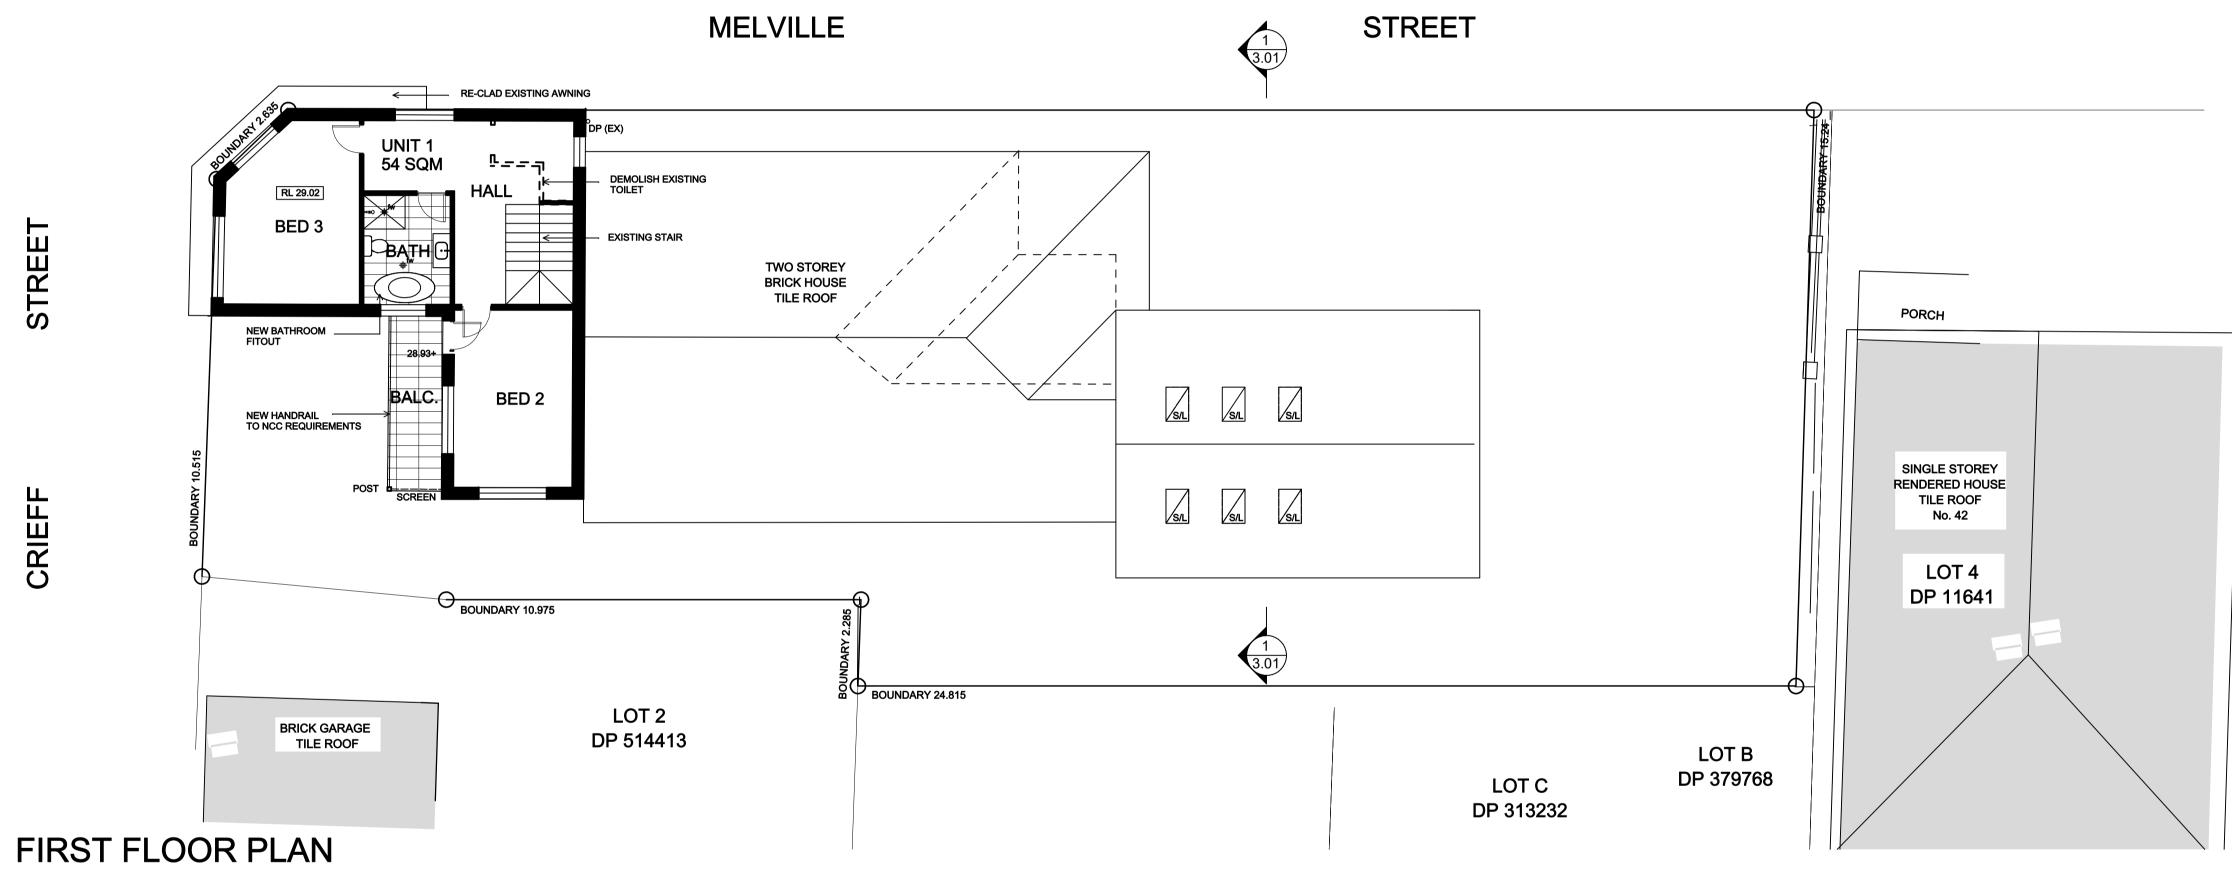


+RL 100.000 PROPOSED LEVEL



PRELIMINARY

A1 DRAWN: AP		>∕∖// =I	
October 2023	3 Cabarita Road Cabarita NSW 2137	ARCHITEC	TS
DRAWING NO: ISSUE NO:	m 0405 257 100 e apavela@pavelaarchitects.net.au	Architect: Anthony Pavela	Reg. No: 7206
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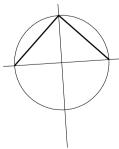
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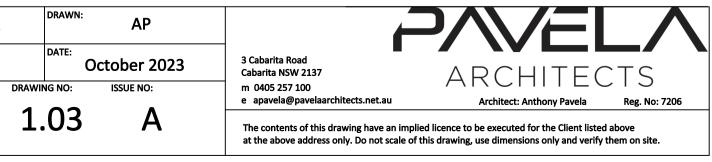
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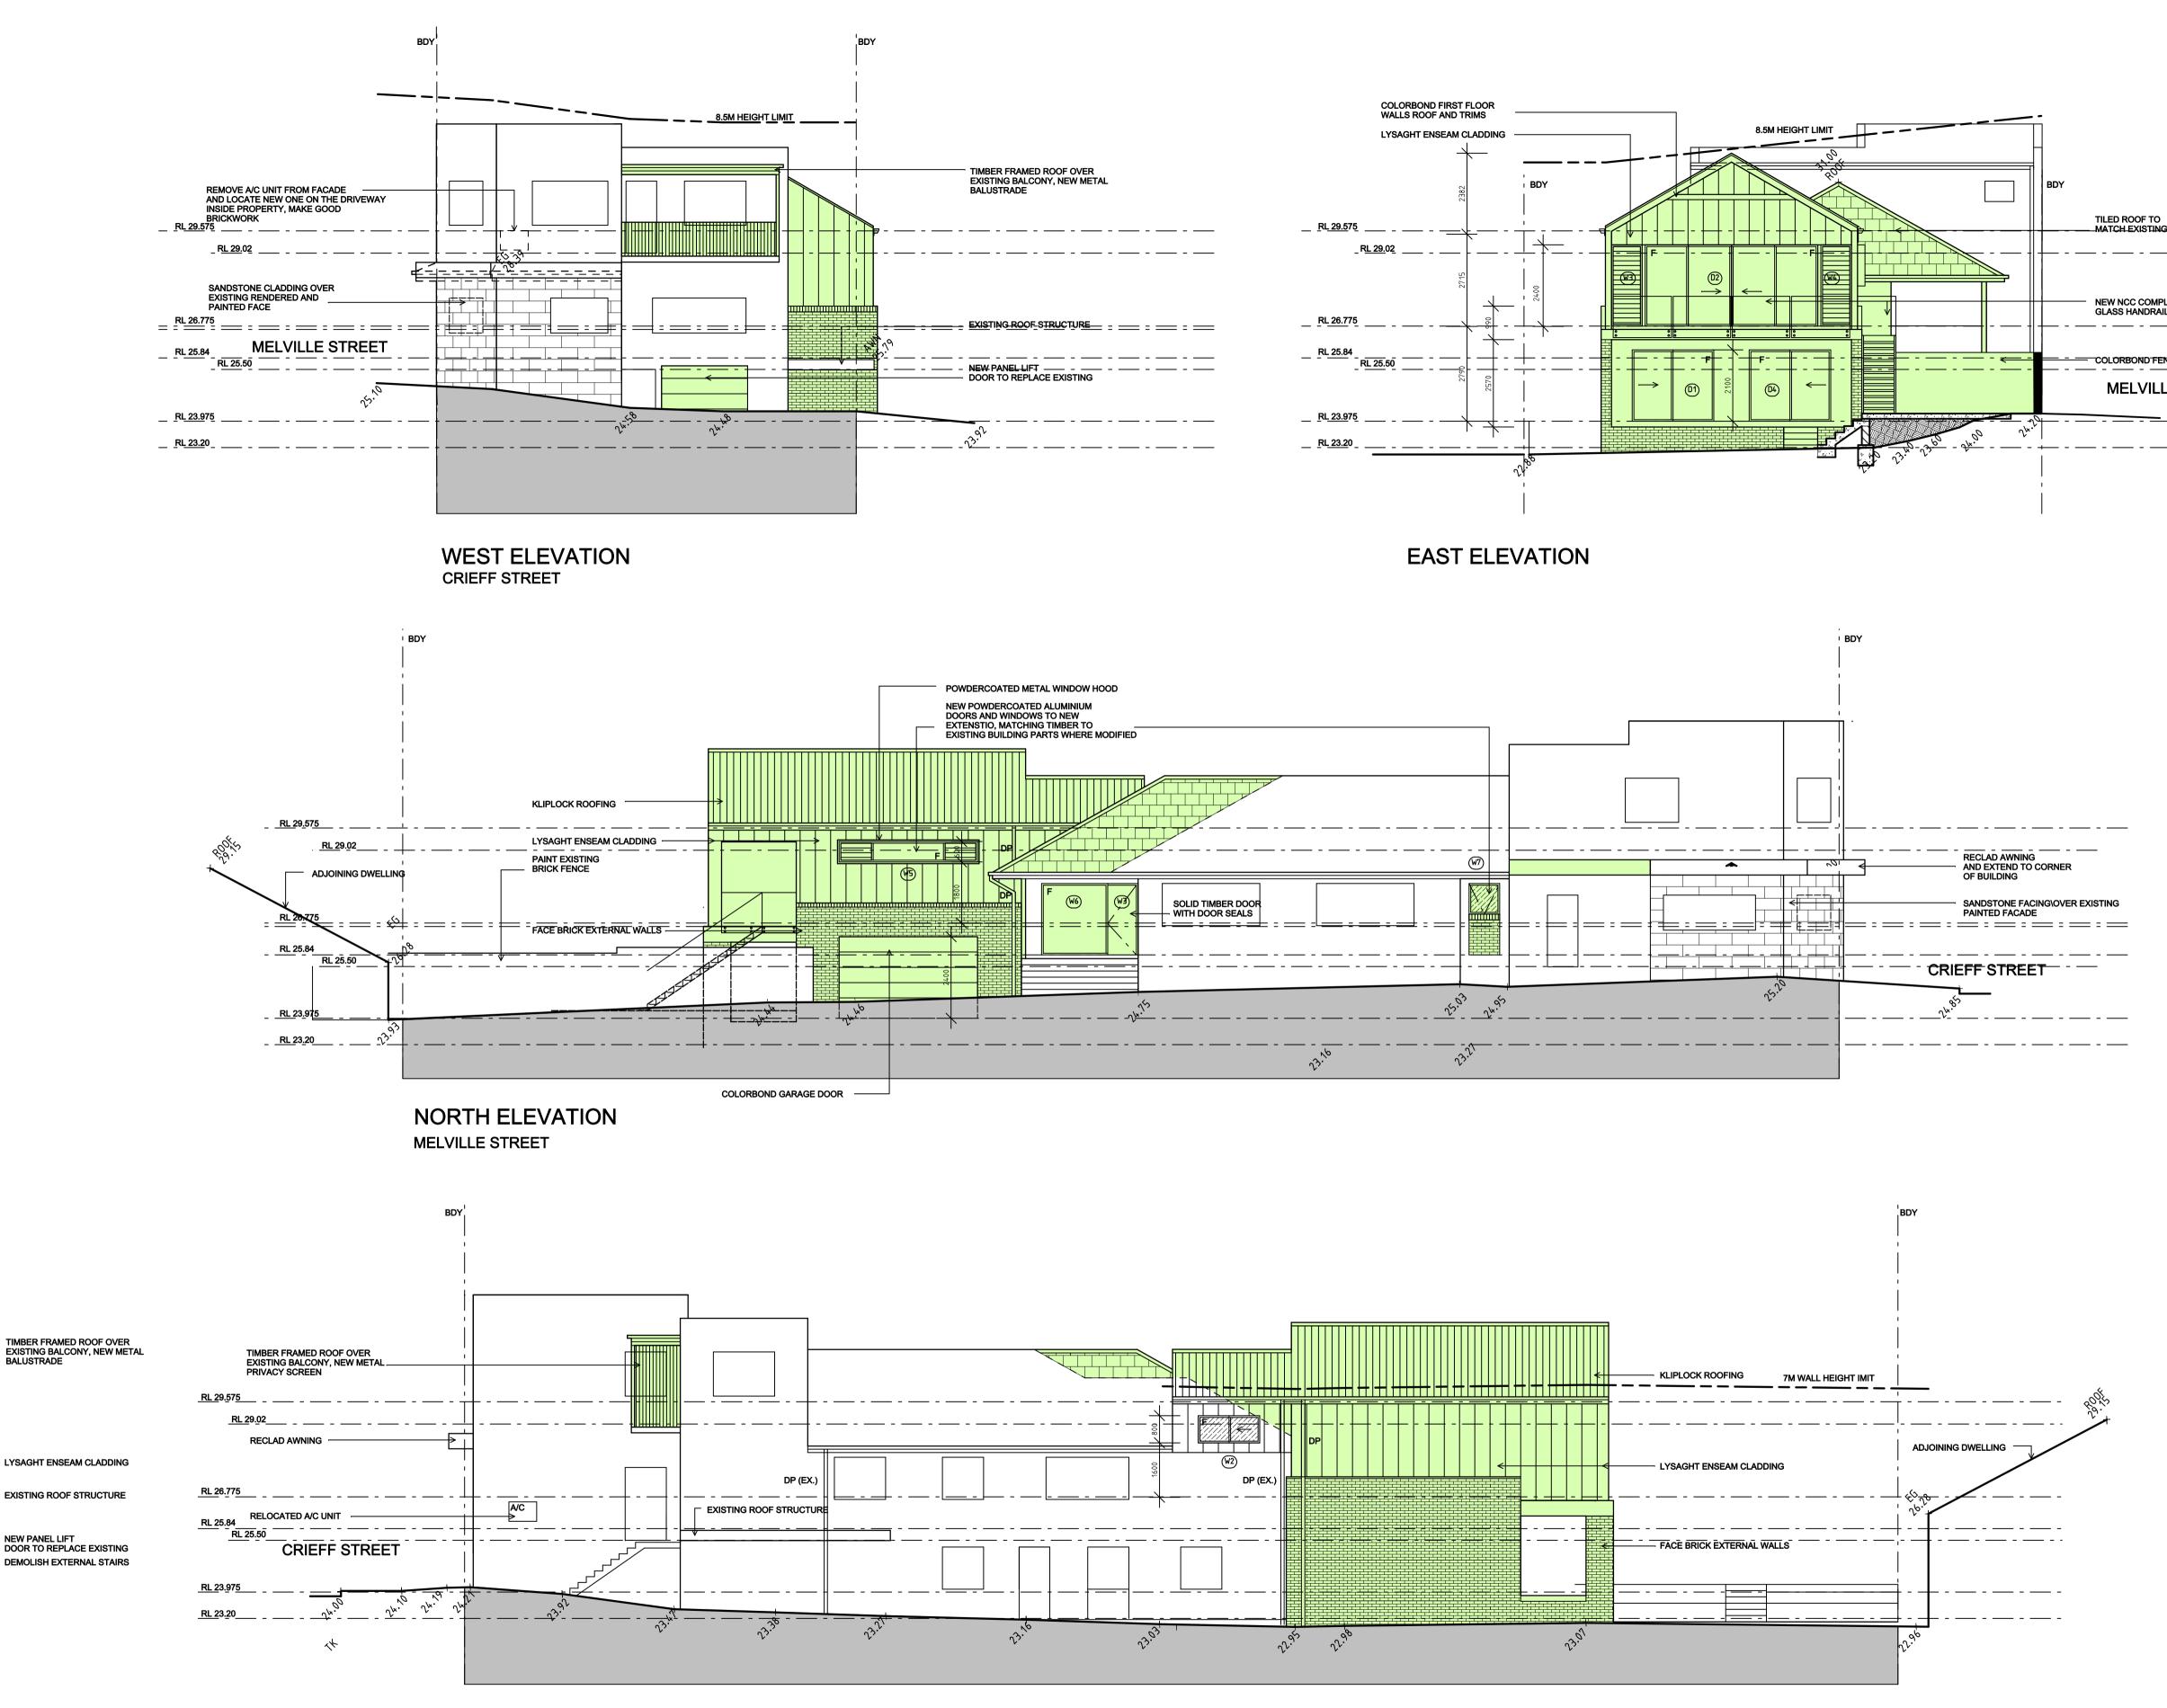
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EXISTING LEVEL +RL 100.000 PROPOSED LEVEL







SOUTH ELEVATION

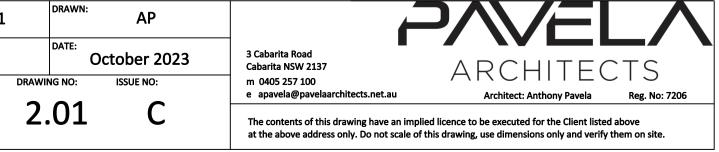
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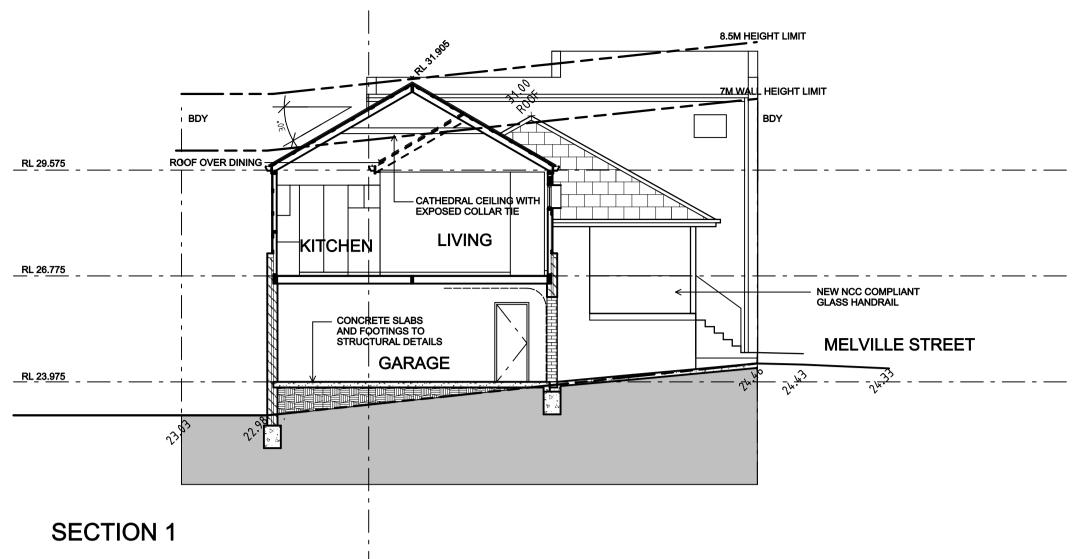
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BASIX NOTES

Min. 40% of new light fittings to use fluorescent, compact fluorescent or LED lamps All new showerheads & taps to have a flow rate no greater than 9 l/min. or a min. 3 star water rating All new tollets to use no greater than 4 litres per average flush or a min. 3 star water rating No insulation required for new floor above garage Min. R1.16 insulation to be added to new brick veneer external walls Min. R1.3 insulation to be added to new external walls with lightweight cladding No insulation required to new internal wall shared with garage Min. R2.5 insulation to new ceilings Foil sarking under new roof

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